




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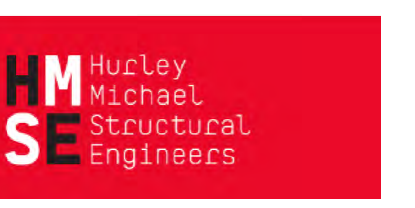
1 COMPOSITE ROOF FRAMING PLAN
SCALE: 1/24" = 1'-0"

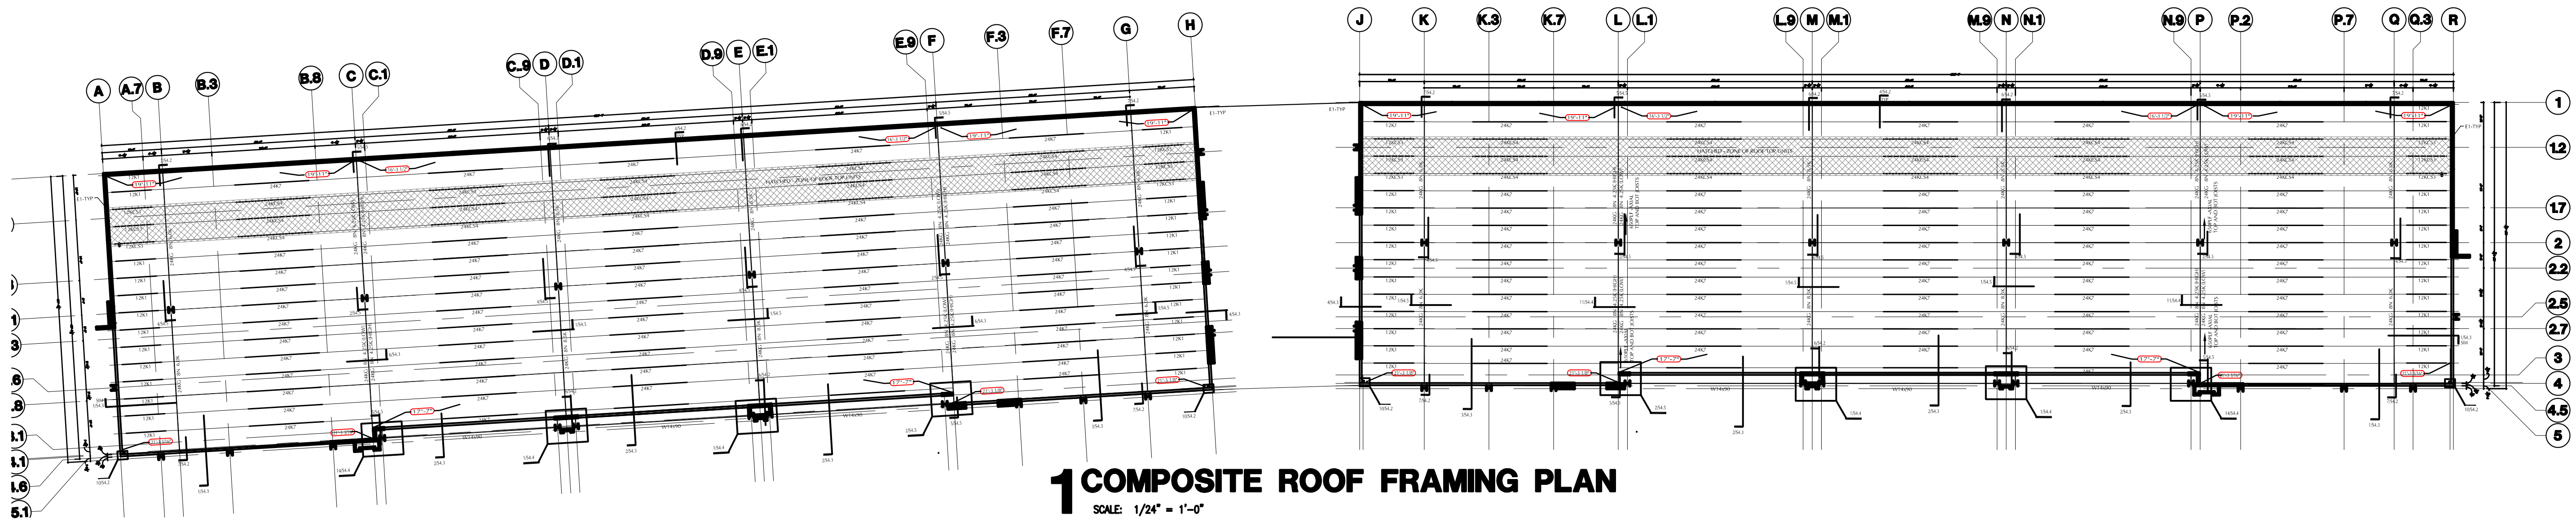

2 CANOPY FRAMING PLAN
SCALE: 1/24" = 1'-0"

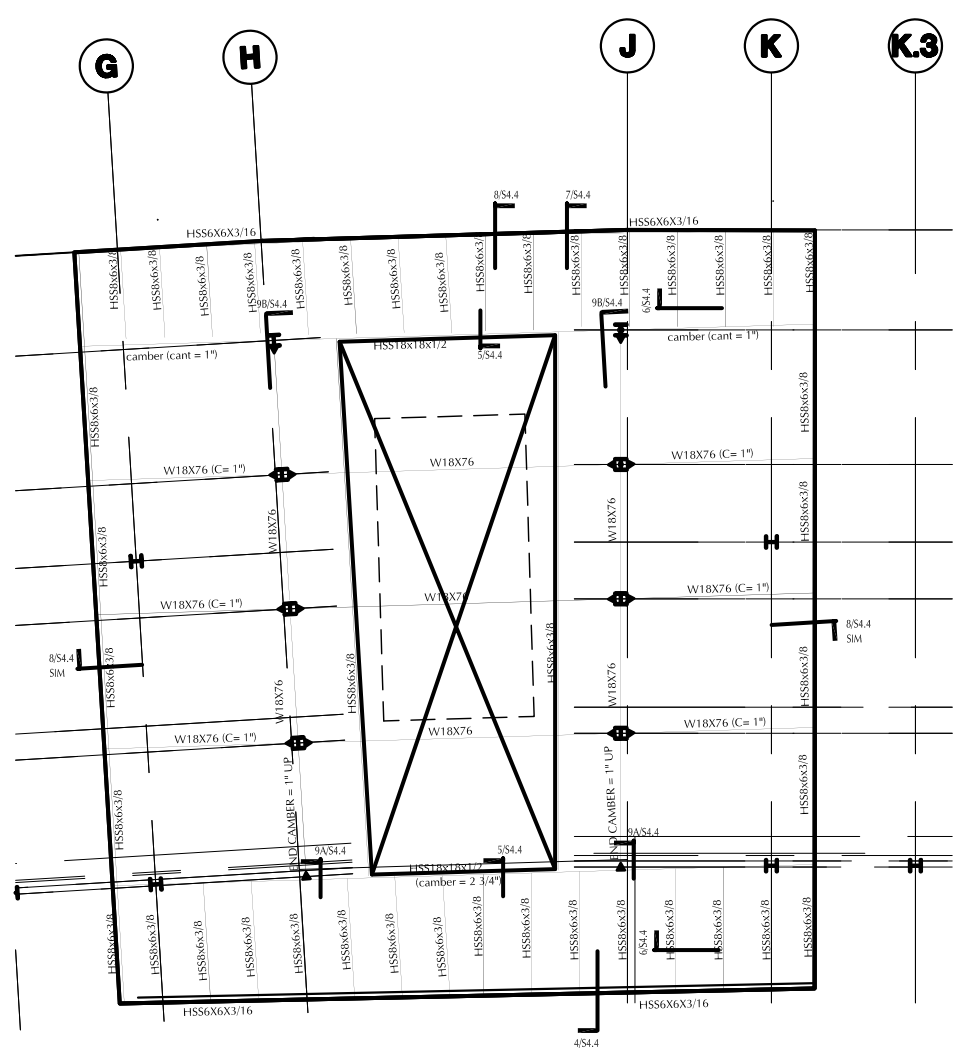

3 COMPONENT AND CLADDING WIND LOADING DIAGRAM
SCALE: 1/16" = 1'-0"

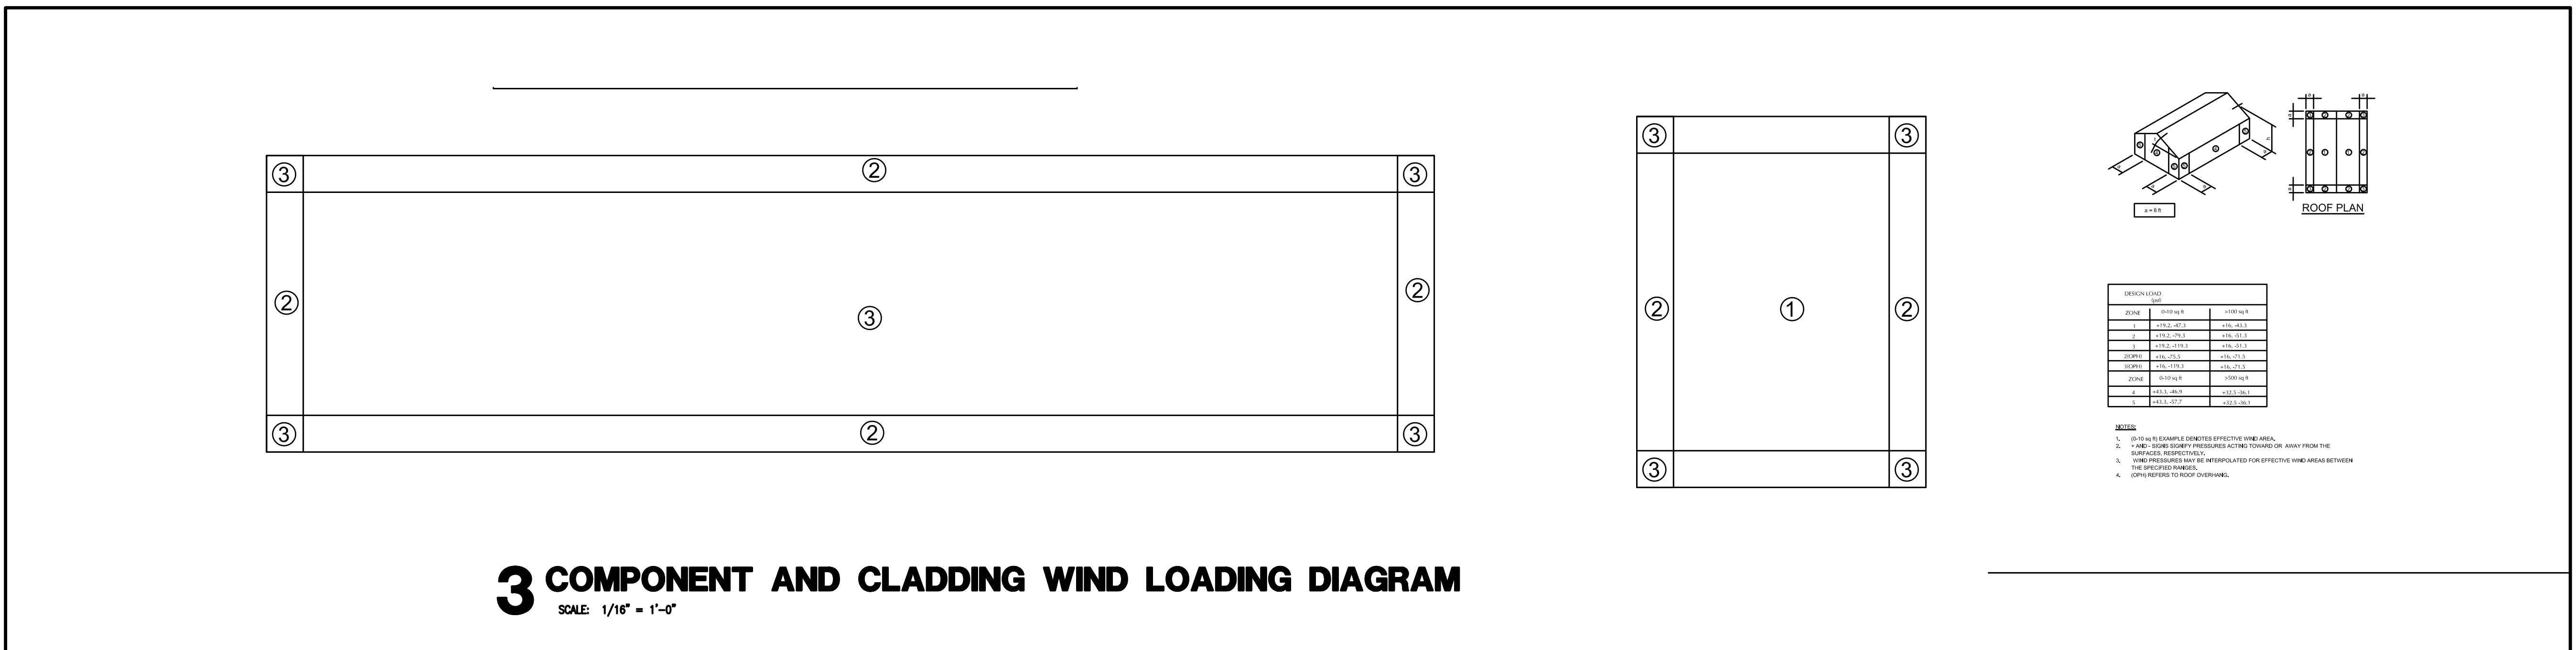

SHOPS ON GOSLING
RETAIL CENTER
SHELL BUILDING DEVELOPMENT
24909 GOSLING ROAD
SPRING, TEXAS 77389

Sheet Title:

**ROOF FRAMING
COMPOSITE
PLAN
AND
WIND PRESSURE
ZONES**

Issue:

CD/PERMIT

Issue Date:

12 MARCH 2019

Revision Date:

Sheet:

S2.0